# APPLICATION FOR LANDFILL CLOSURE CAP MODIFICATION FORMER EDWARDS ROAD LANDFILL PERMIT NO. 34-05

#### GENERAL NOTES

- 1. THE GENERAL NOTES AND LEGEND PROVIDED ON THIS SHEET APPLY TO ALL DRAWINGS, UNLESS OTHERWISE INDICATED.
- 2. THESE DRAWINGS ARE INTENDED FOR APPLICATION PURPOSES ONLY, AND ARE NOT RELEASED FOR CONSTRUCTION.
- 3. CONTOUR LINES ARE INDICATED AT 2-FOOT INTERVALS WITH ELEVATIONS MEASURED ABOVE MEAN SEAL LEVEL (MSL) DATUM, UNLESS OTHERWISE INDICATED.
- 4. SCALES AS ARE INDICATED ON EACH DRAWING.
- 5. EXISTING CONTOURS REPRESENT THE TOPOGRAPHY OF THE SITE IN 2008 FROM NC FLOODPLAIN MAPPING PROGRAM AND 2005 FORSYTH COUNTY INFORMATION.
- 6. CONTRACTOR SHALL NOTIFY NORTH CAROLINA "DIG SAFE" (1-800-632-4949) AT LEAST 3 DAYS PRIOR TO SUBSURFACE DISTURBANCE. CONTRACTOR SHALL BE RESPONSIBLE FOR VERIFYING THE LOCATION OF ALL SITE UTILITIES PRIOR TO THE INITIATION OF ANY EXPLORATORY OR CONSTRUCTION ACTIVITIES.
- 7. CONTRACTOR SHALL MANAGE STORMWATER THROUGHOUT CONSTRUCTION ACTIVITIES AND PREVENT THE MIGRATION OF SEDIMENTS FROM THE SITE.
- 8. CONTRACTOR SHALL INSTALL TEMPORARY, AS REQUIRED, AND THREE PERMANENT BENCHMARKS PRIOR TO CONSTRUCTION. THE LOCATION OF ALL BENCHMARKS SHALL BE FIELD DETERMINED BY THE ENGINEER. ALL BENCHMARKS SHALL BE PROTECTED AND/OR RELOCATED IF A BENCHMARK MUST BE DISTURBED DURING CONSTRUCTION. BENCHMARKS SHALL BE REFERENCED TO THE NATIONAL GEODETIC VERTICAL DATUM (NGVD).
- 9. CONTRACTOR SHALL CONTROL AND MONITOR ALL CONSTRUCTION ACTIVITIES ON THE SITE TO ASSURE THAT NO ENVIRONMENTAL RELEASES TO OFFSITE AIR AND WATER RESOURCES OCCURS; ANY RELEASES SHALL IMMEDIATELY BE REPORTED TO THE OWNER, ENGINEER AND APPROPRIATE REGULATORY AGENCIES.
- 10. TOTAL DISTURBED ACREAGE FOR THE PROJECT IS 22.88 ACRES.
- 11. PROPERTY IS OWNED BY R. J. REYNOLDS TOBACCO CO.

REVISION

NO. DATE APPR.

12. PROPERTY IS LOCATED IN THE YADKIN-PEE DEE RIVER BASIN.


# LIST OF DRAWINGS

DRAWING NO.	TITLE
	COVER SHEET
1.	EXISTING SITE CONDITIONS
2.	GRADING PLAN
3.	EROSION & SEDIMENTATION CONTROL PLAN
4.	EROSION & SEDIMENTATION CONTROL DETAIL SHEET
<b>5.</b>	LANDFILL FINAL CAP CONSTRUCTION DETAILS


NO.	DATE	AFFN.	INEVISION	INO. DATE	AFFN. KEVISION	DIDAL HALL ACH LANDUH
						RURAL HALL ASH LANDFILL
						RURAL HALL, NORTH CAROLINA
						DI DEVALOI DO EODA COO COMBANDA
						R.J. REYNOLDS TOBACCO COMPANY
						WINSTON-SALEM, NORTH CAROLINA


REVISION


NO. DATE APPR.

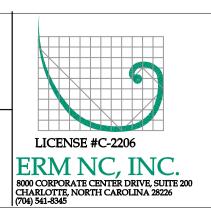

CHECKED	DATE					DRAWING NO.	
PROJECT DESIGNER D. WASIELA	6/3/11	_	COVER SHE	ET			0
PROJECT ENGINEER  D. WASIELA			LANDFILL CLOSURE M				
PROJECT MANAGER D. WASIELA							REV. NO.
APPROVED		DRAWN CJM	DATE 6/3/11	CLIENT APPROVAL			0
APPROVED		SCALE AS NOTED	w.o. no. 0103137	ISSUED FOR	DATE	SHEET	OF

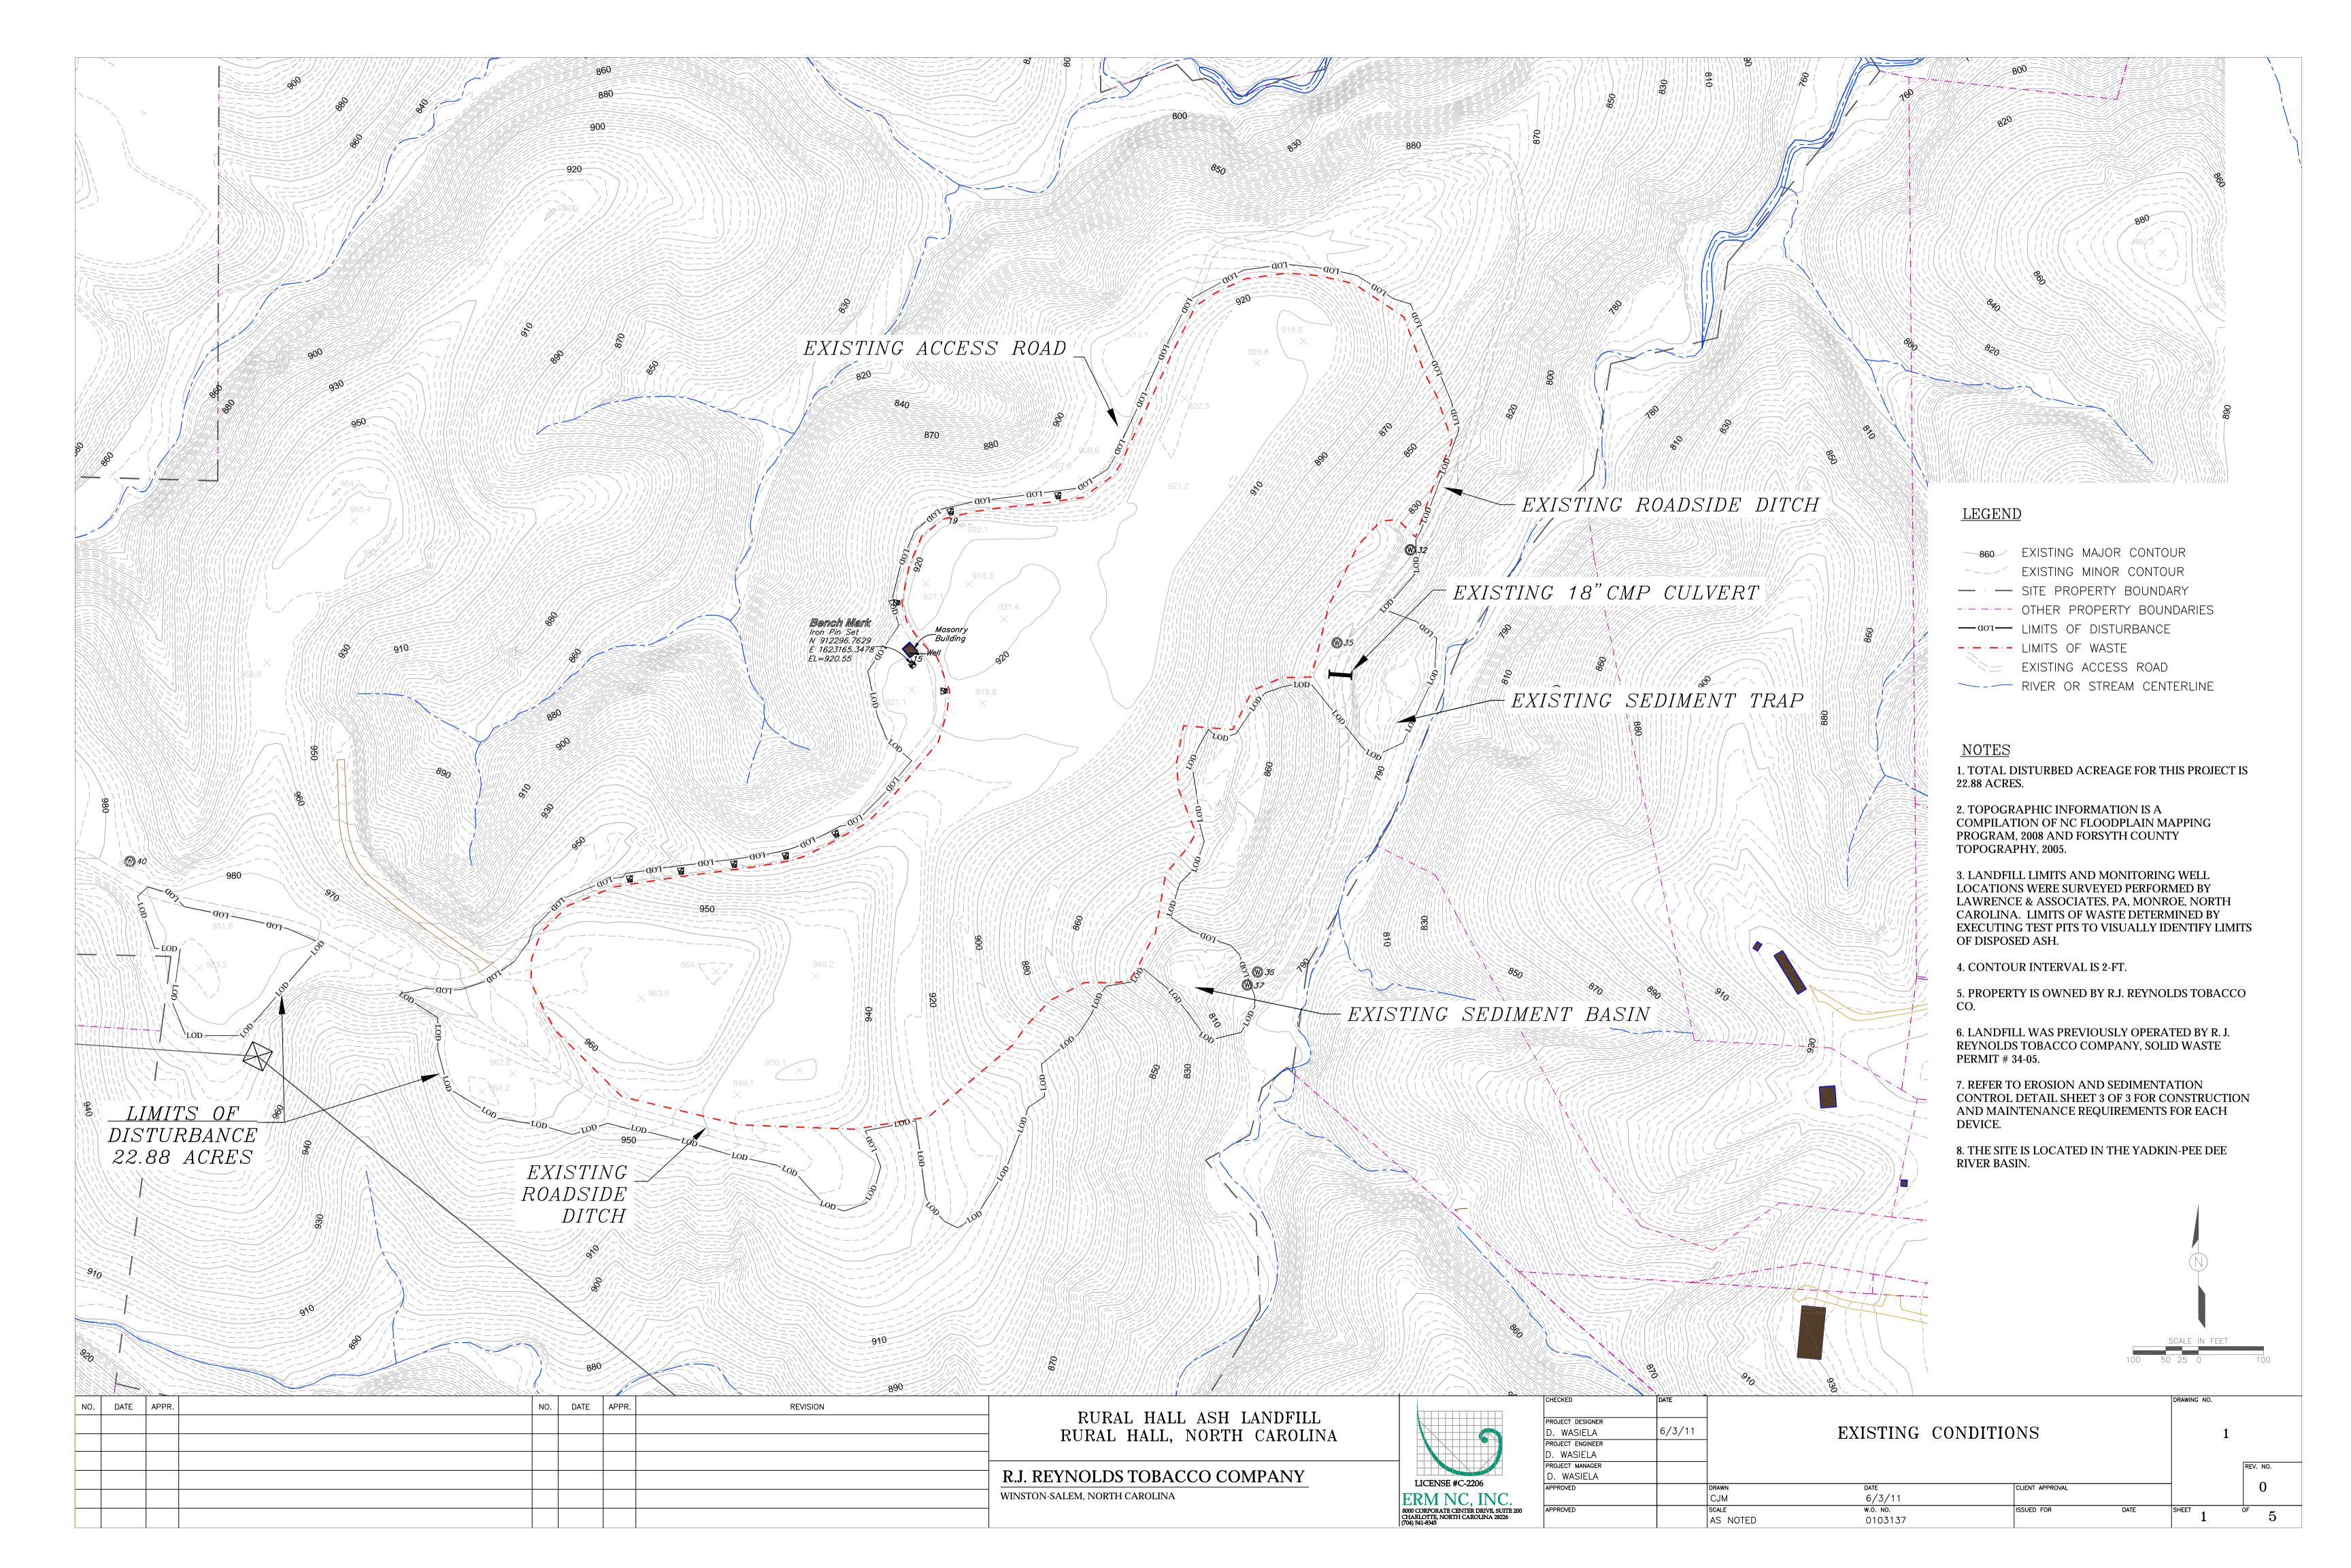

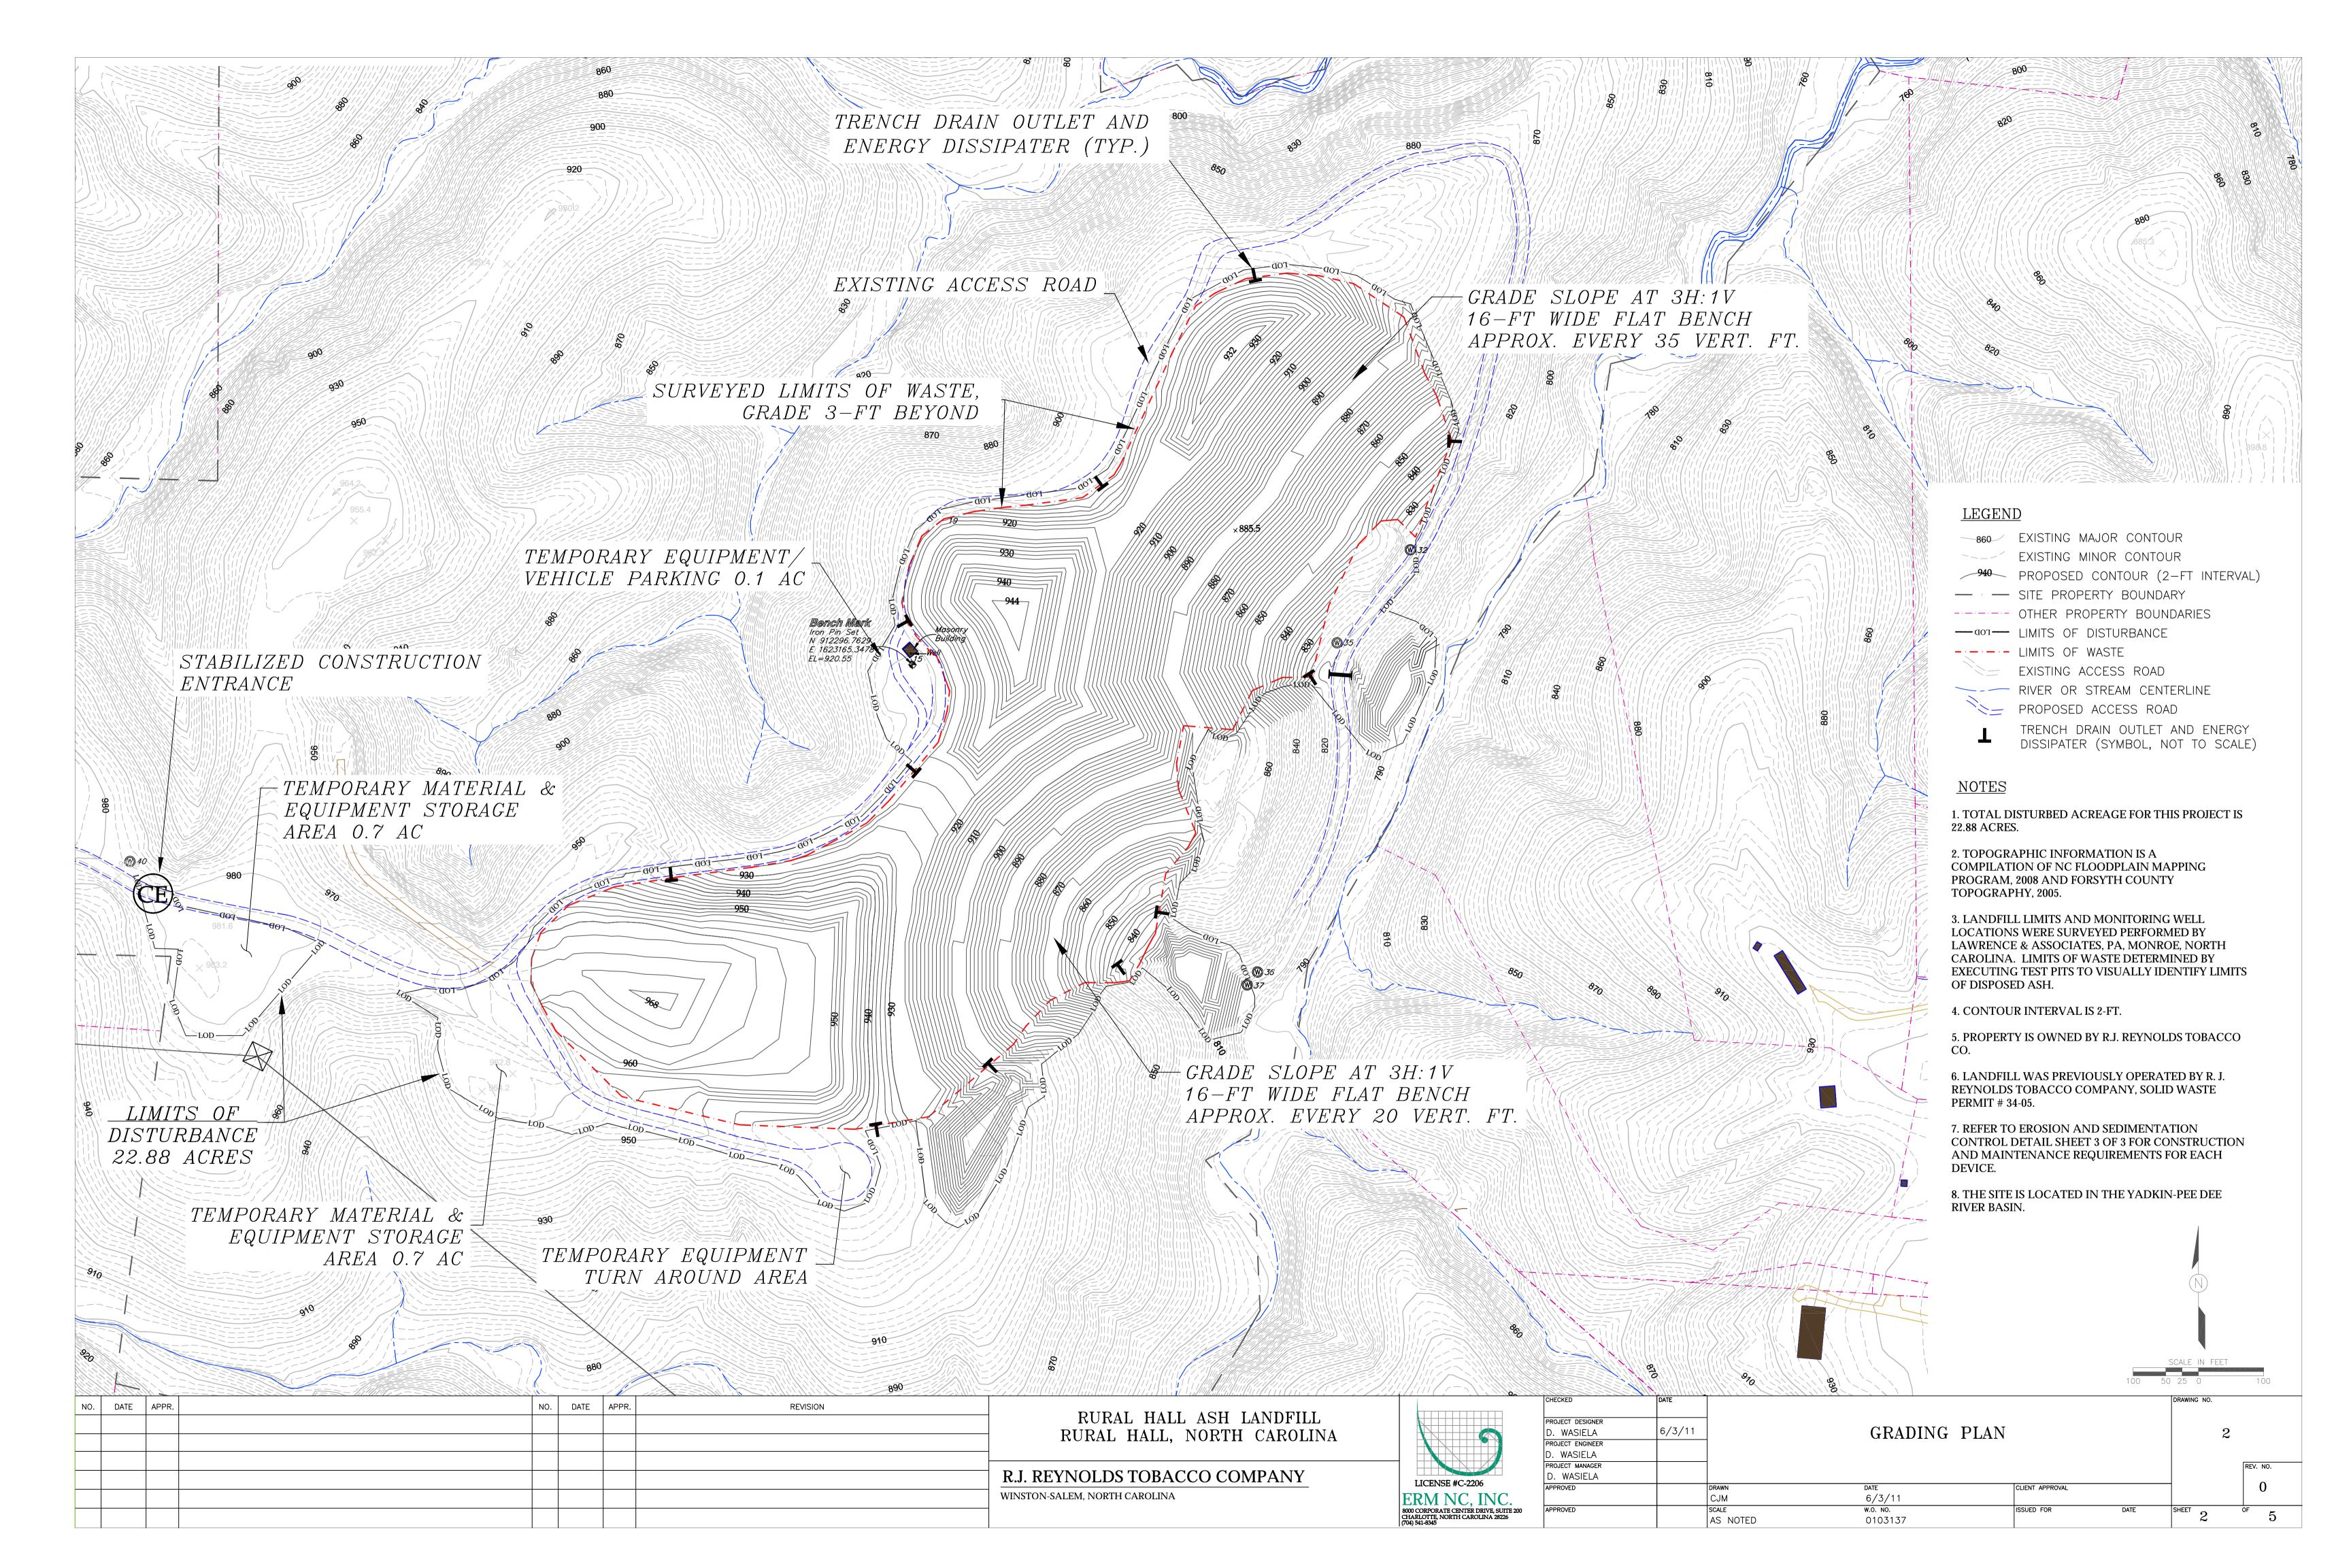

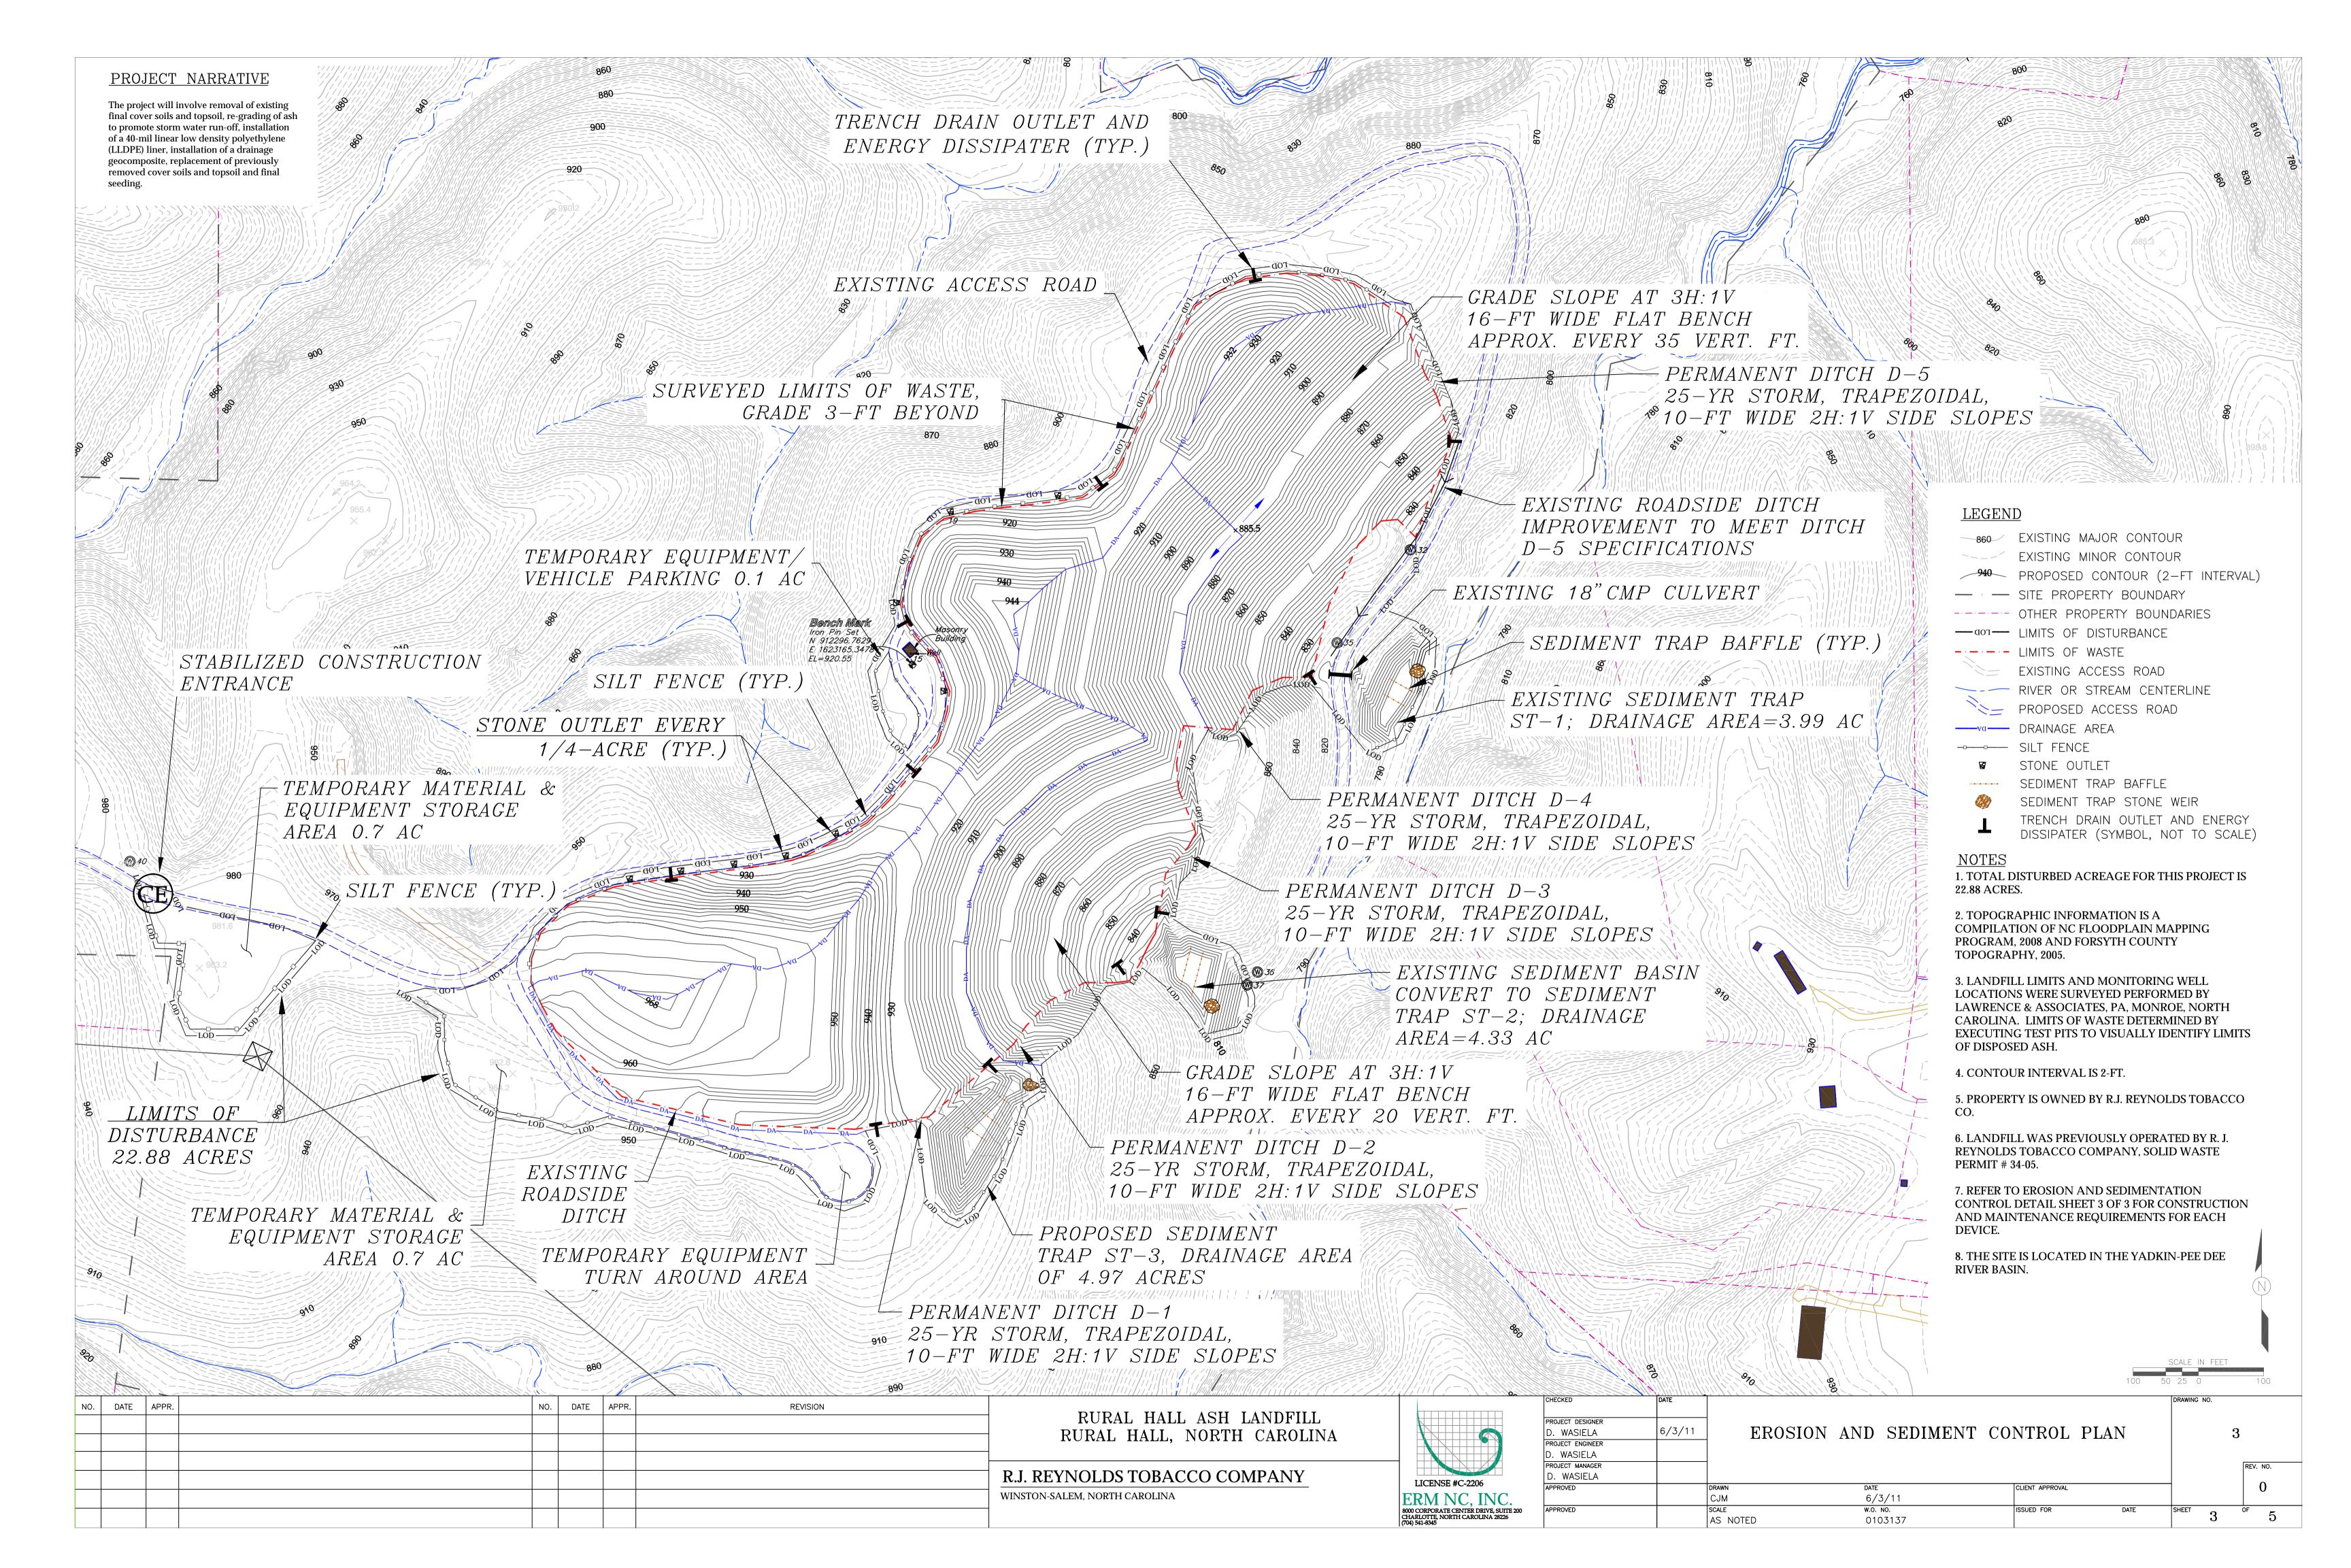

#### CONSTRUCTION SEQUENCE

- 1. A pre-construction meeting should take place prior to start of construction activities.
- 2. Construction will occur in three phases of approximately equal area (i.e. in thirds). Each construction phase will consist of installation of E&S measures, preparation of stockpile areas, stripping and
- staging of topsoil, cap construction, and restoration (including establishment of vegetation). 3. Begin clearing and grubbing site. Clear and grub only those areas necessary for installation of the erosion control measures.
- 4. Install silt fence, sediment basins, diversion ditches, etc. Install a clean-out stake in each sediment
- basin as shown in sediment basin details. Basins to be cleaned out when it fills to the halfway mark. 5. Once erosion control measures have been installed and prior to mass grading activities, the site is to
- be inspected by NCDENR Land Quality. 6. Grade site according to contract documents. Maintain erosion control devices as needed.
- 7. Install storm drainage as indicated on plans.
- 8. Grass or otherwise stabilize all areas as they are brought to final grades. 9. The contractor shall diligently and continuously maintain all erosion control devices and structures to minimize erosion. Inspect and repair measures after each rainfall and as needed throughout the
- 10. Contractor to leave all erosion control devices in place at the conclusion of his contract. Contractor is to clean-out, repair and grass stabilize all denuded areas.
- 11. It is the contractor's responsibility to contain sediment onsite. Additional erosion control measures may be required by the Engineer.
- 12. All erosion control measures to be in accordance with the North Carolina Erosion and Sediment
- Control Planning and Design Requirements and Land Development Standards. 13. All graded slopes must be seeded and mulched within 15 days of completion of grading. All remaining areas are to be seeded and mulched within 120 days. The angle for graded slopes and fills shall be no greater than the angle which can be retained by vegetative cover or other adequate erosion control devices or structures.
- 14. Additional measures to control erosion and sediment may be required by a representative of the NCDENR - Land Quality Section.
- 15. Any land-disturbing activity > 5 acres requires compliance with all conditions of the General Permit to Discharge Storm Water Under the National Pollutant Discharge Elimination System (Permit No. NCG120000). Any permit noncompliance is a violation of the Clean Water Act and may require enforcement action by the North Carolina Department of Environment and Natural Resources.

#### SEEDBED PREPARATION NOTES

- 1. Surface water control measures to be installed according to plan.
- 2. Areas to be seeded shall be ripped and spread with available topsoil 3" deep.
- 3. Loose rocks, roots and other obstructions shall be removed from the surface so that they will not interfere with establishment and maintenance of vegetation. Surface for final seedbed preparation, at finish grades shown, shall be reasonably smooth and uniform.
- 4. If no soil test is taken, fertilizer and lime to be according to seeding specifications above. In addition,
- provide 15 lbs./1000 s.f. of super phosphate. 5. If soil test is taken, provide fertilizer and lime according to soil test report.
- 6. Fertilizer and lime shall be applied uniformly and mixed with the soil during seedbed preparation.
- 7. Additional erosion control measures may be required depending on field conditions.
- 8. Mulch to be tacked or mechanically tied down within two days after mulch is spread.
- 9. Buffer zones to be used only as specifically denoted on plans. 10. Borrow and fill to be balanced on site.
- 11. Re-fertilize in the second year unless growth is fully adequate. May be moved once or twice a year, but mowing is not necessary. Re-seed, fertilize, and mulch damaged areas immediately.

#### **SEEDING SPECIFICATIONS:**


Planting Rate Aug. 15 - Nov. 1 300 lb. /ac. or 7 lb. /1000 s. f. Tall Fescue 300 lb. /ac. or 7 lb. /1000 s. f. Nov. 1 - Mar. 1 Tall fescue and 25 lb./ac. or 1/2 lb./1000 s.f. Abruzzi Rye Mar. 1 - Apr. 15 Tall Fescue 300 lb./ac. or 7 lb./1000 s.f. 30 lb./ac. or 1 lb./1000 s.f. Apr. 15 - Jul. 30 Mulled Common Bermudagrass Jul. 15 - Aug. 15 Tall Fescue and 300 lb./ac. or 7 lb./1000 s.f. Browntop Millet or 35 lb./ac. or 7/8 lb./1000 s.f. Sorghum Sudan Hybrids 30 lb./ac. or 3/4 lb./1000 s.f.

Mulch with straw applied at the rate of 75-100 lb./1000 s.f.

Heavily mulched during January — March period. Apply agricultural lime at the rate of 90 lb./1000 s.f.


Apply 10-10-10 commercial fertilizer at the rate of 20 lb./1000 s.f.


Tack: Asphalt tie down — 225 gal./ac.

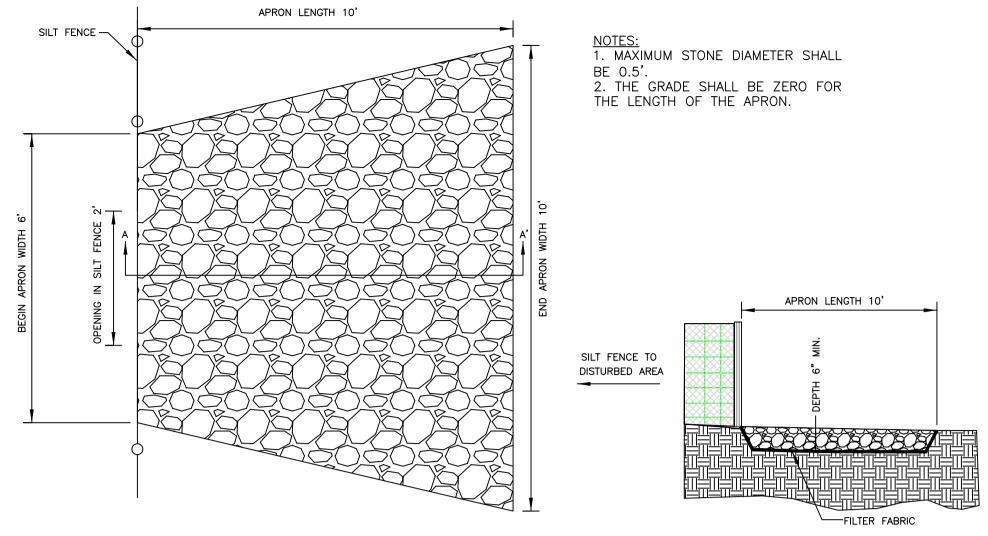

## SILT FENCE STONE OUTLET

SECTION A-A'

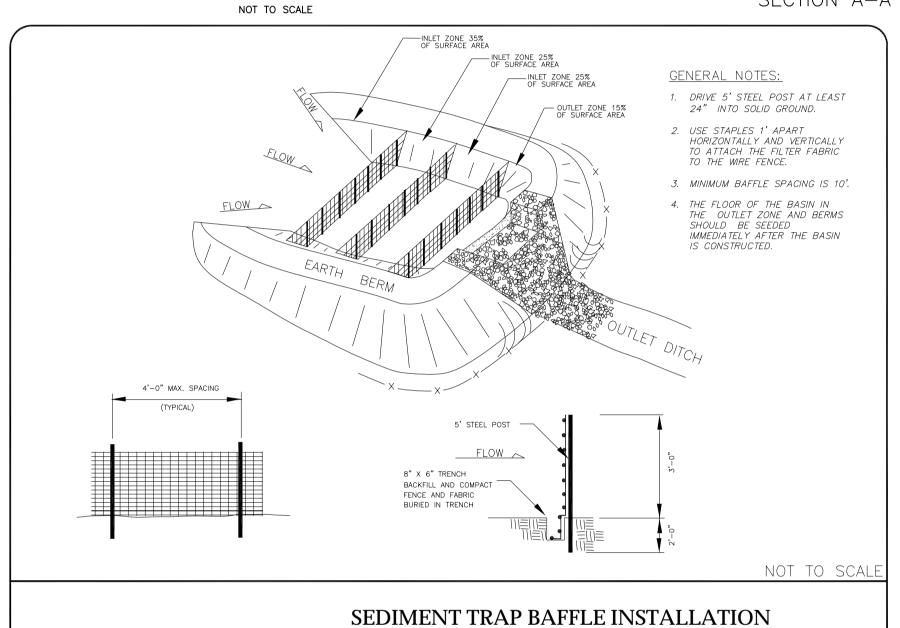

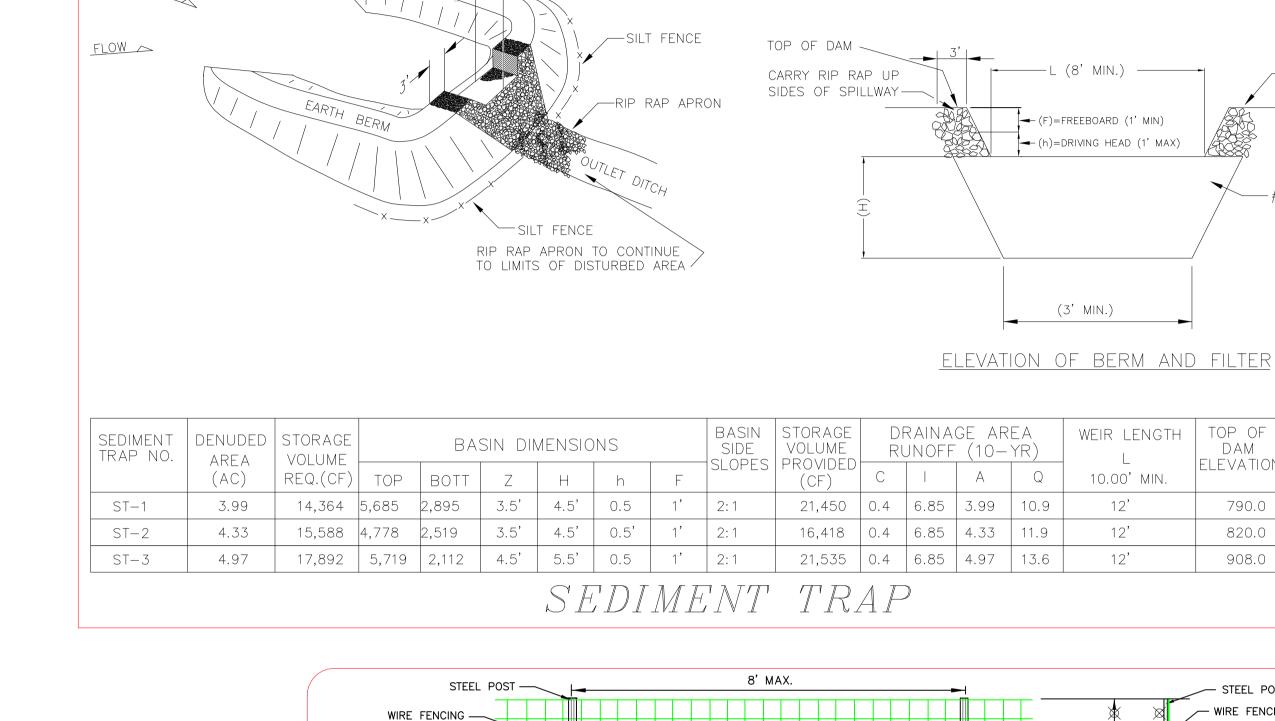

(H)=WEIR HEIGHT


MAXIMUM LEVEL OF SEDIMENT-

COLLECTED (CLEAN BASIN OUT

WHEN THIS LEVEL REACHED)


(Z)=SEDIMENT STORAGE

CLEAN OUT STAKE-

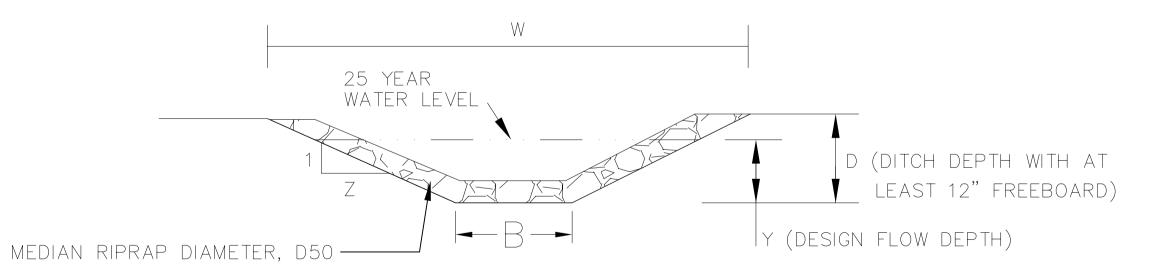


													Q <sub>25</sub> PROV.	
DITCH NO.	С		A(AC.)	Q <sub>25</sub> (CFS)	S(MIN.) (ft./ft.)	D <sub>50</sub>	Z	D	В	W	Y	V(FPS)	FULL FLOW (CFS)	COMMENTS
D-1	0.23	5.11	3.24	3.8	0.138	12"	2	1.5	4	10	0.35	2.36	3.9	D50 PROVIDED > D50 REQUIRED
D-2	0.23	6.05	2.16	3.0	0.257	12"	2	1.5	4	10	0.24	2.95	3.2	D50 PROVIDED > D50 REQUIRED
D-3	0.25	7.58	2.31	4.4	0.164	12"	2	1.5	4	10	0.34	2.89	4.6	D50 PROVIDED > D50 REQUIRED
D-4	0.25	6.05	0.98	1.5	0.32	12"	2	1.5	4	10	0.16	2.57	1.8	D50 PROVIDED > D50 REQUIRED
D-5	0.25	5.11	3.18	4.1	0.132	12"	2	1.5	4	10	0.47	1.80	4.2	D50 PROVIDED > D50 REQUIRED

# DITCH CROSS-SECTION

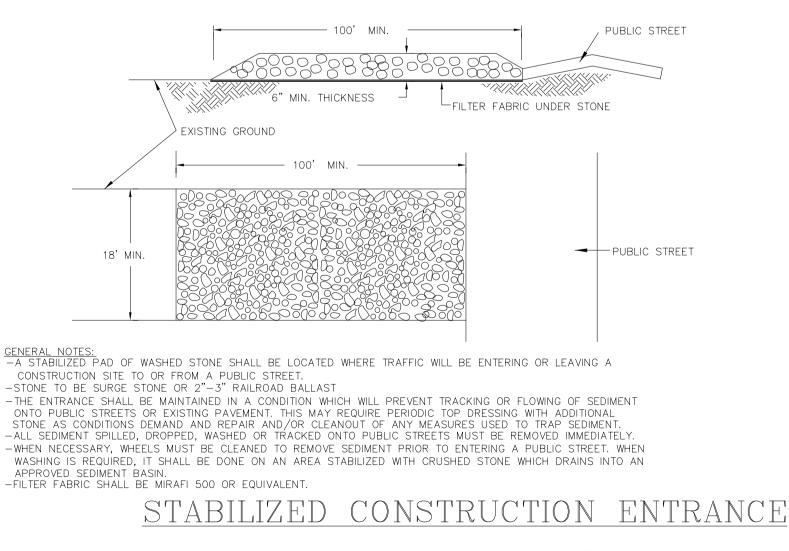

(N. C.	STD.	NO.	6.06)	
--------	------	-----	-------	--

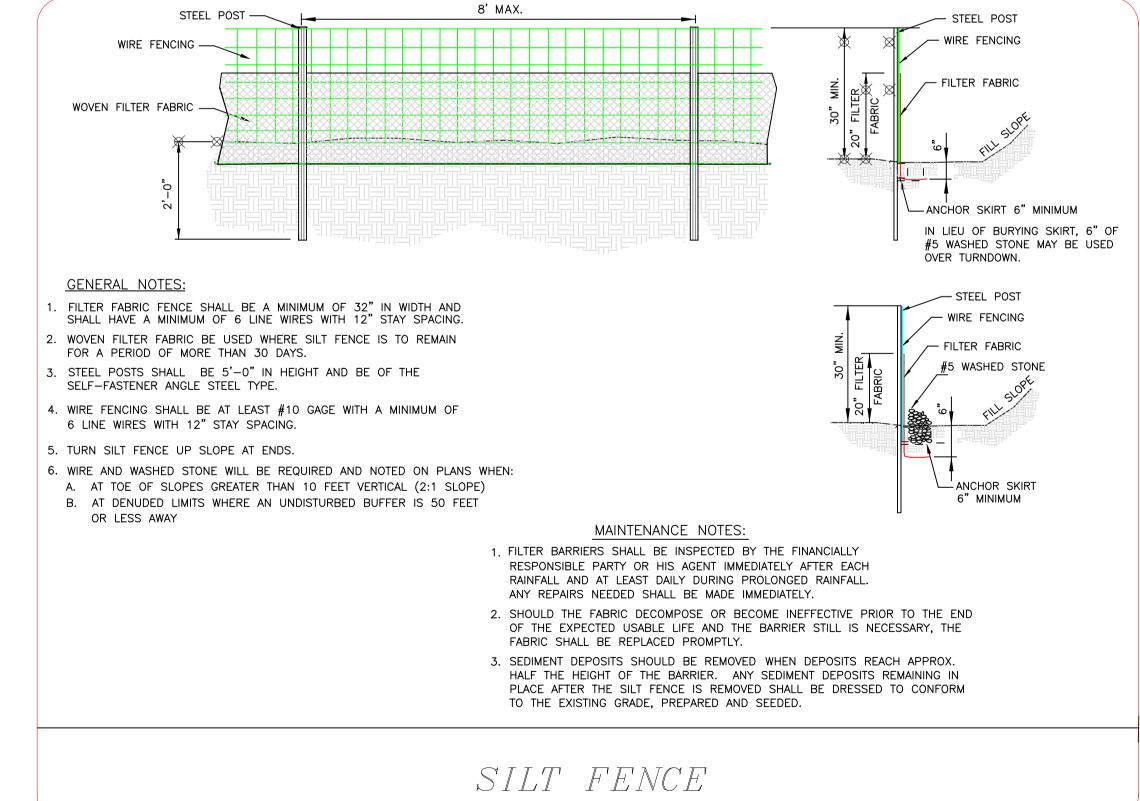

|<del>---</del>2' MIN.<del>---</del>|

(F)=FREEBOARD (1' MIN)

FILTER FABRIC BETWEEN

**RESIDUAL SOIL & STONE** 

WEIR LENGTH | TOP OF

10.00' MIN.

12'

12'

12'

DAM

LEVATION

790.0

820.0

908.0

(h)=DRIVING HEAD (1' MAX)

- #5 WASHED STONE

ELEVATION

788.5

818.5

906.5

TOP OF BERM

RESIDUAL SOIL

1' THICK MIN.

#5 WASHED -

1.5 FT

SECTION THROUGH BASIN AND FILTER

STONE

-1' MIN. FLOOD STORAGE ZONE


NO.	DATE	APPR.	NO.	DATE	APPR.	REVISION
-	1	<u> </u>	+			

RURAL HALL ASH LANDFILL RURAL HALL, NORTH CAROLINA


R.J. REYNOLDS TOBACCO COMPANY WINSTON-SALEM, NORTH CAROLINA


LICENSE #C-2206
ERM NC, INC. 8000 CORPORATE CENTER DRIVE, SUITE 200 CHARLER, NORTH CAROLINA 28226

CHECKED	DATE		EROSION & SEDI	MENTATION		DRAWING	NO.	
PROJECT DESIGNER D. WASIELA	6/3/11		CONTRO					4
PROJECT ENGINEER	-/ -/	+						4
D. WASIELA			DETAIL SH	1EET				
PROJECT MANAGER		7						REV. NO.
D. WASIELA								
APPROVED		DRAWN	DATE	CLIENT APPROVAL		7		0
		CJM	6/3/11					
APPROVED		SCALE AS NOTED	w.o. no. 0103137	ISSUED FOR	DATE	SHEET	4	<sup>o</sup> F 5

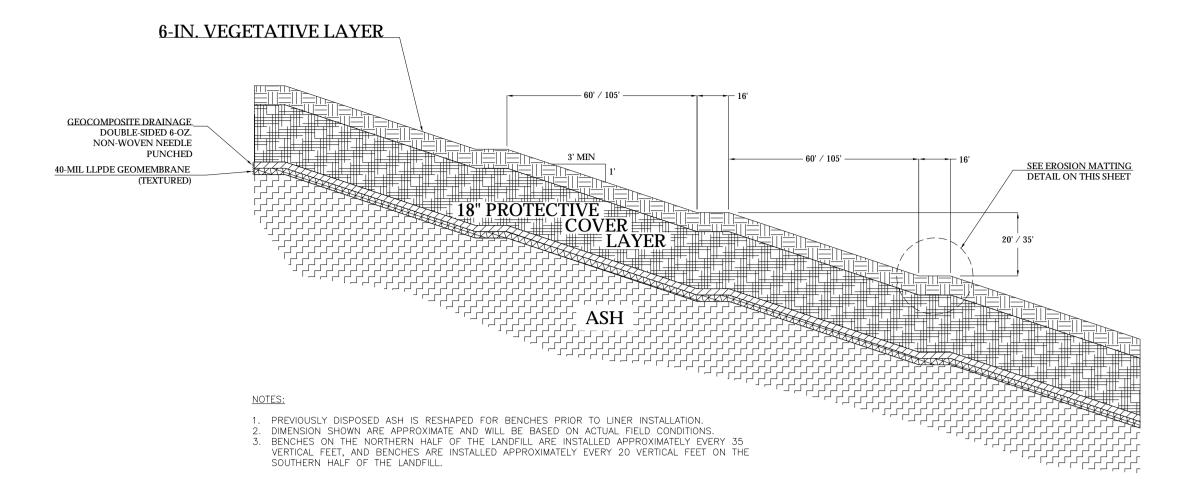



EAST SLOPE BENCHING DETAIL

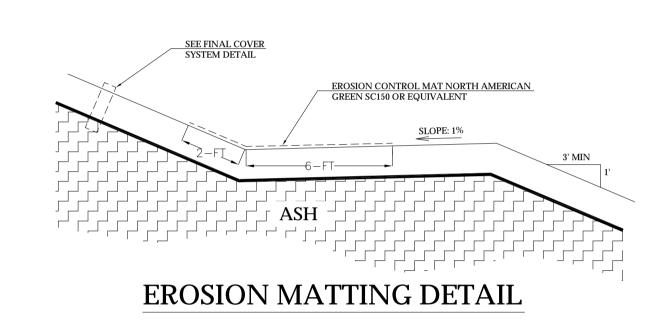

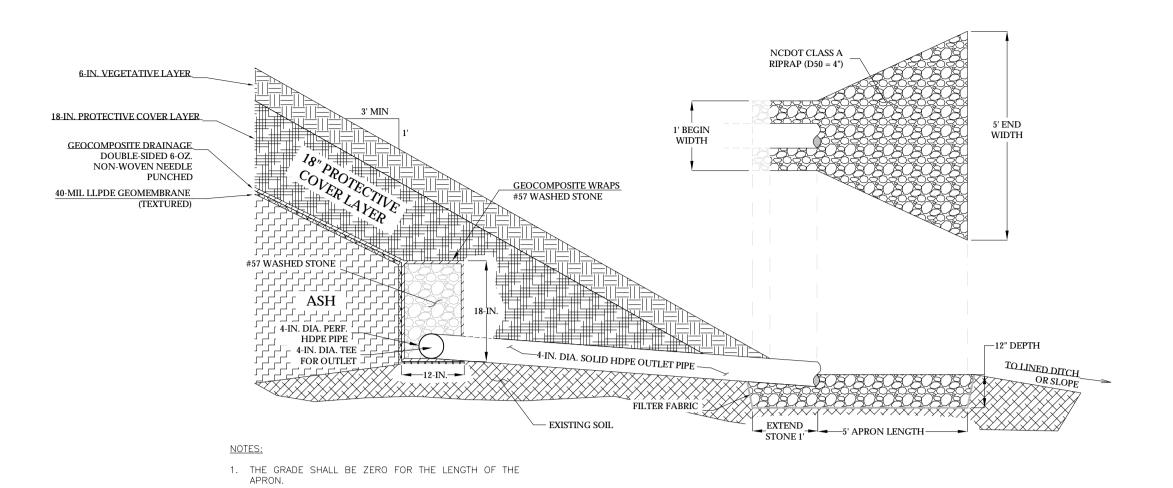

### ANCHOR TRENCH AND DRAIN OUTLET DETAIL

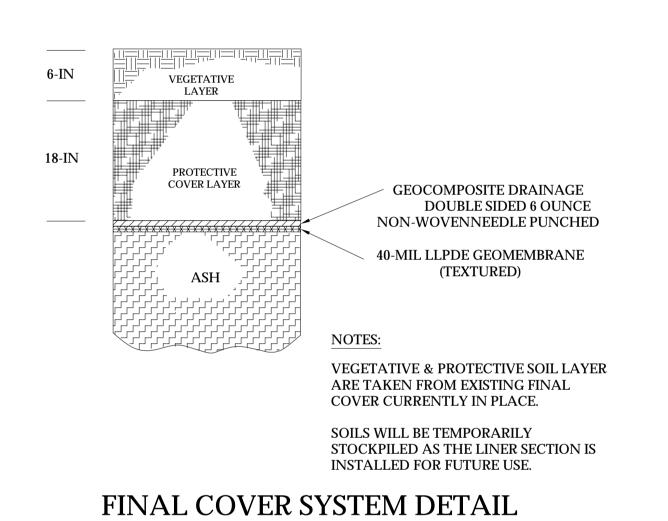

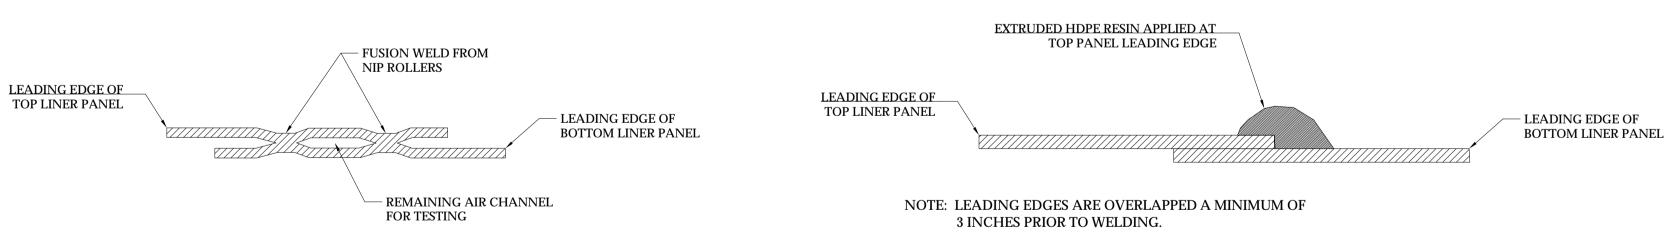

#### LLDPE DOUBLE HOT WEDGE FUSION WELD DETAIL


NOTES:

1. LEADING EDGES ARE OVERLAPPED A MINIMUM OF 6 INCHES PRIOR TO WELDING.
2. HDPE SURFACES SHALL BE CLEANED FREE OF DEBRIS AND SOIL PRIOR TO WELDING.

# LLDPE EXTRUSION WELD DETAIL

NOTES:

1. LEADING EDGES ARE OVERLAPPED A MINIMUM OF 6 INCHES PRIOR TO WELDING.
2. HDPE SURFACES SHALL BE CLEANED FREE OF DEBRIS AND SOIL PRIOR TO WELDING.
3. GRINDING OF HDPE SURFACES SHALL BE PERFORMED IN AREAS RECEIVING EXTRUDATE PRIOR TO WELDING TO SUPPLY AN ABRASIVE SURFACE. GRINDING BEYOND THE AREA RECEIVING EXTRUDATE IS NOT ALLOWED.

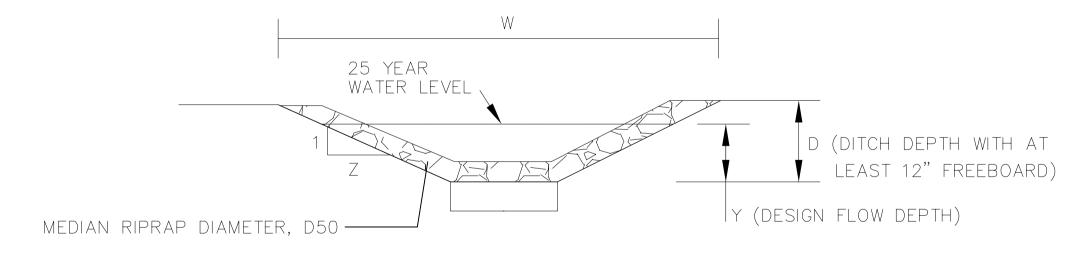

													Q <sub>25</sub> PROV.	
DITCH NO.	С		A(AC.)	Q <sub>25</sub> (CFS)	S(MIN.) (ft./ft.)	D <sub>50</sub>	Z	D	В	W	Y	V(FPS)	FULL FLOW (CFS)	COMMENTS
D-1	0.23	5.11	3.24	3.8	0.138	12"	2	1.5	4	10	0.35	2.36	3.9	D50 PROVIDED > D50 REQUIRED
D-2	0.23	6.05	2.16	3.0	0.257	12"	2	1.5	4	10	0.24	2.95	3.2	D50 PROVIDED > D50 REQUIRED
D-3	0.25	7.58	2.31	4.4	0.164	12"	2	1.5	4	10	0.34	2.89	4.6	D50 PROVIDED > D50 REQUIRED
D-4	0.25	6.05	0.98	1.5	0.32	12"	2	1.5	4	10	0.16	2.57	1.8	D50 PROVIDED > D50 REQUIRED
D-5	0.25	5.11	3.18	4.1	0.132	12"	2	1.5	4	10	0.47	1.80	4.2	D50 PROVIDED > D50 REQUIRED

## DITCH CROSS-SECTION

NO.	DATE APPR.	REVISION	NO. DATE APPR.	REVISION						DRAWING NO.	
1	7-14-11 DWW East :	Slope Benching Detail; vegetative cover thickness from 16-in. to 6-i	in.		RURAL HALI	L ASH LANDFILL		LANDFILL F	INAL CAP CONSTRUCTION	5	
					R.J. REYNOLDS TOBACCO COMPANY	RURAL HALL, NORTH CAROLINA			DETAILS		
					DRAWN BY	PROJECT ENGINEER	LICENSE #C-2206	SCALE	DATE	0	
					D. WASIELA		ERM NC. INC.	NTS	6/7/2010		
					DESIGN ENGINEER D. WASIELA	PROJECT MANAGER	8000 CORPORATE CENTER DRIVE, SUITE 200 CHARLOTTE, NORTH CAROLINA 28226 (704) 541-8345	PROJECT NO. 0103137	AutoCAD 2002  LANDFILL CAP DETAILS.DWG	SHEET 5 OF 5	